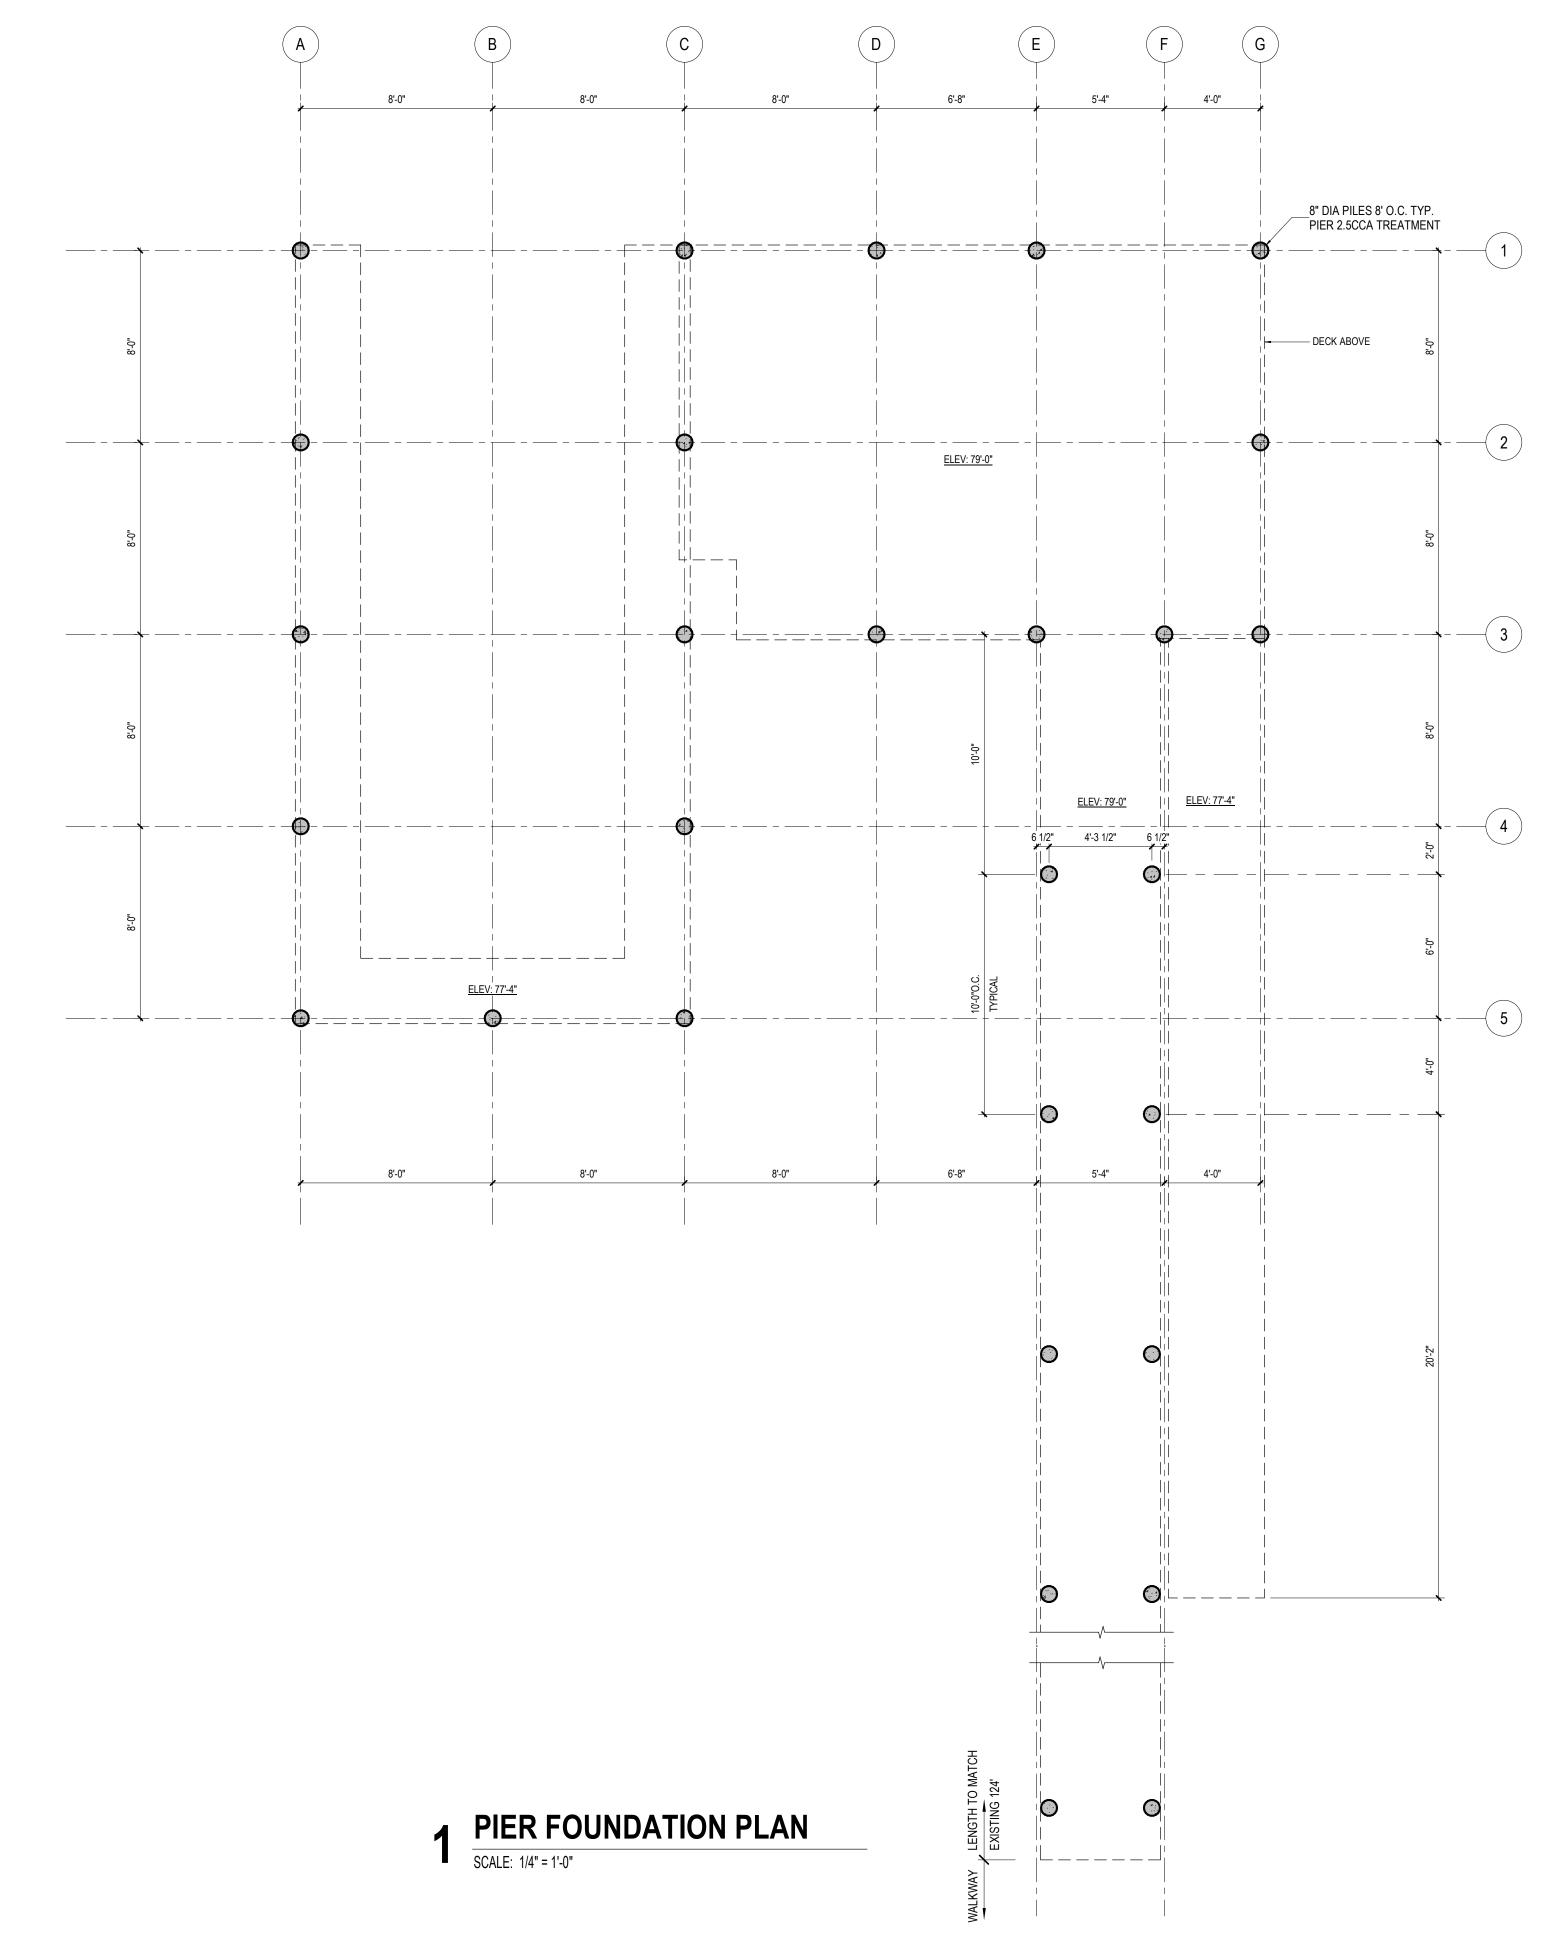
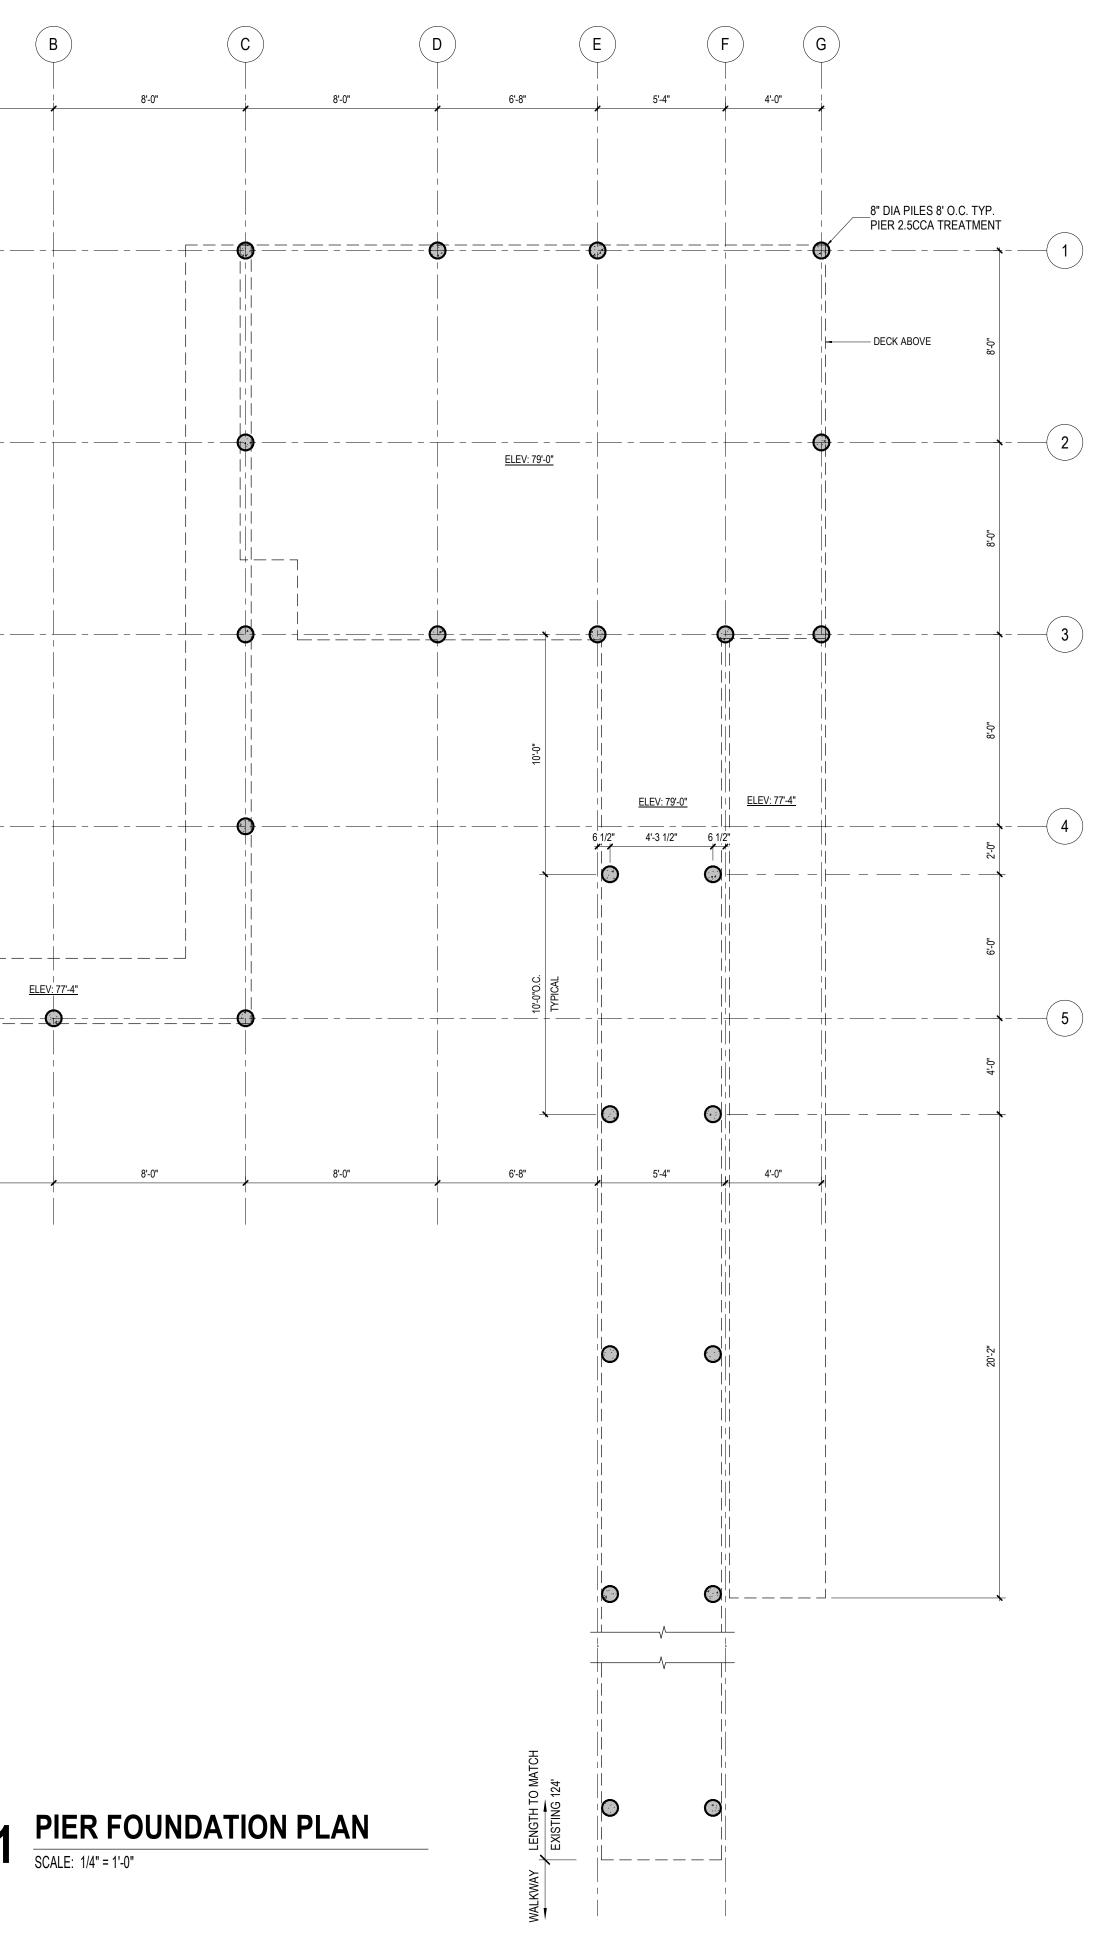


					O. 843-785-0 General Notes: The mea specifications shown on t construction use only. Th structure may vary. This	DESIGN STUDIC & CUSTOM HOMES Rd Hilton Head, SC 2992 888 C. 843-540-6824 surements, dimensions, and other his document are guidelines for le actual specifications of the finishe document may not be relied on as e completed structure will look like.
	AREA C/		N			
COVERED - BOAT	NAME		AREA 522.0	67 SF		
COVERED - BOAT COVERED - PIER JNCOVERED - DE				4 SF		
INCOVERED - LC	WER DECK		100.0 1640.4	00 SF		
			1226.1			
OTAL UNDER RO	JUF		1226.	0 SF		
	LINI	ETYPES				
			Centerline Demolished			
			— Hidden Line			
			 Overhead 1 Hour Fire Rating 			
			2 Hour Fire Rating			
			Electrical Wiring Matchline			
			Property Line			
			Project Limit Line			
	MAT	[ERIALS				
	Earth		Plywood			
	Granular Fill		Insulation Roof			
· · · ·	Bituminous Paving		Insulation Rigid		X U	
	Concrete		Batt Insulation			
	Existing		Stucco/Plaster		Ш	
	Concrete Masonary		Gypsum Board			
	Metal		<u>.</u>	,	8	10 10
			Wood - Finish Carpentar	y		2943
	Glazing/Acrylic	- ` , , , <u>` ; , ` ;</u>	Spray Fireproofing			SC Rd
	Rough Carpentry		Metal Insulated Panel		Ш	Butter Rd neau, SC
	ABBR	EVIATIONS				911 Butter Bonneau, (
∠ ang		IN	inch			О Ш
⊈ cer □ cha	iterline annel cent	INT JST LBS or #	interior joist pounds	[
@ at ACT acc	oustical ceiling tile	LIN LF	linear lineal feet			
AFF abo	ustable ove finish floor handling unit	LPT MAINT MAX	low point maintenance maximum			
ALT alte AUTO aut	omatic	MEP MFR	mechanical, electrical, plumbing manufacture(r)			
BD boa B.M. ber BM bea	nchmark	MIN MISC MTL	minimum miscellaneous metal			
CIP cas CL cer	st-in-place sterline	MULL NO. or #	mullion number			
	ling ncrete masonry unit umn	NTS OC OPG	not to scale on center opening			
CONC cor CONT cor	ncrete htinuous	OPP PNL	opposite panel		NO. DESCR	RIPTION DATE
DBL dou DIA dia	d water uble meter	PREFAB PTL PVC	prefabricated pressure treated lumber polyvinyl chloride			
DIM dim DN dow	nension vn	QTY R or RAD	quantity radius			
ELEV ele	wing vation	REBAR RECP REF	reinforcing bar receptacle reference			
EQ equ EXG exis	ual sting	REINF REQD	reinforcement(ed) required			
FDN fou FFL or FFE finis		REV RM SF	revision room square foot		SHEET NAME	
FIN finis FT or ' foo	sh t / feet	SIM SPEC	similar specifications		COV	/ER PAGE
FV fiel GA gau		STD STGR	square foot standard stringer		PROJECT STATUS	
GAL gal	lon vanized	STL STRUCT	steel structural		PROJECT NUMBER	CD'S PROJECT DATE
GALV gal	and a strantor	THK	thick		211076	04/30/2021
GALV gal GC Ger GL gla	neral Contractor ss / glazing und	TYP U.N.O.	typical unless noted otherwise		DRAWN BY	CHECKED BY
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WINSLOW DESIGN STUDIO & CUSTOM HOMES

34 New Orleans Rd Hilton Head, SC 29928 O. 843-785-0888 C. 843-540-6824

General Notes: The measurements, dimensions, and other specifications shown on this document are guidelines for construction use only. The actual specifications of the finishe structure may vary. This document may not be relied on as a representation of what the completed structure will look like.

TRIPLE ZINC G-185 CONTAINS ROUGHLY THREE TIMES THE AMOUNT OF ZINC AS THE STANDARD G60 GALVANIZING. THIS PROVIDES ADDITIONAL PROTECTION AGAINST CORROSION ATTRIBUTED TO THE NEW WOOD PRESERVATIVES. UNFORTUNATELY, WE ARE UNABLE TO PREDICT THE SERVICE LIFE OF PARTICULAR CONNECTORS IN SELECTED ENVIRONMENTS. WE CAN, HOWEVER, PROVIDE A RELATIVE LEVEL OF PROTECTION INFORMATION REGARDING CORROSION RESISTANCE. FROM THIS WE CAN ROVIDE GUIDANCE FOR THE SELECTION OF CORROSION PROTECTION BASED ON THE ANTICIPATED ENVIRONMENTAL CONDITIONS.

HERE ARE SOME GUIDELINES TO FOLLOW: POTENTIAL FOR CORROSION SHOULD BE A PART OF THE

- CONNECTOR SELECTION CRITERIA
- FOR ALL KNOWN CORROSIVE ENVIRONMENTS, THE BEST AVAILABLE CORROSION RESISTANT OPTION IS TO USE
- STAINLESS STEEL CONNECTORS AND FASTENERS.
- FOR EXTERIOR APPLICATIONS AND WITH TREATED WOOD, THE USE OF HDG OR TRIPLE ZINC CONNECTORS WITH HDG FASTENERS IS RECOMMENDED AS A MINIMUM FOR CORROSION
- PROTECTION. ASK FOR AND FOLLOW RECOMMENDATIONS OF THE PRESERVATIVE WOOD TREATER FOR USE OF CONNECTORS
- AND FASTENERS IN CONTACT WITH THEIR BRAND OF TREATED
- WOOD PRODUCT.
- CONNECTORS AND THEIR FASTENERS SHOULD ALWAYS BE OF LIKE MATERIALS USP'S WS WOOD SCREWS ARE NOT RECOMMENDED FOR
- USE WITH PRESERVATIVE OR FIRE-RETARDANT TREATED WOOD.
- FOR ANY QUESTIONS CONTACT USP TECHNICAL ASSISTANCE

CONNECTOR: USE WITH PRESERVATIVE TREATED WOOD

FOR MINIMUM CORROSION PROTECTION, USP STRUCTURAL CONNECTORS RECOMMENDS CONSUMERS USE TRIPLE ZINC G-185 OR HDG CONNECTORS IN ALL OUTDOOR APPLICATIONS AND WITH TREATED LUMBER. IN GENERAL, CONNECTORS, INCLUDING ANCHORS AND FASTENERS, INSTALLED IN CORROSIVE ENVIRONMENTS OR EXPOSED TO CORROSIVE MATERIALS, OR CHEMICALS, CAN BE DAMAGED, POSSIBLY RESULTING IN THE REDUCTION OF LOAD VALUES. STANDARD G60 CONNECTORS SHOULD NOT BE INSTALLED IN POTENTIALLY CORROSIVE ENVIRONMENTS.

CORROSION IS A MULTIFACETED PHENOMENON DEPENDENT ON MANY VARIABLES. MOST OF THESE VARIABLES ARE RELATED TO THE ENVIRONMENT THE STEEL IS PLACED IN. CORROSION CAN OCCUR LEADING TO LOSS OF STRENGTH AND REDUCED CONNECTOR LOAD CARRYING CAPABILITY DUE TO EXPOSURE TO OCEAN AIR OR SALT SPRAY, CHEMICALS USED IN FIRE RETARDANT AND PRESERVATIVE TREATED WOOD, ACID RAIN, AGRICULTURAL CHEMICALS AND FERTILLIZERS, ANIMAL WASTES, SWIMMING POOL CHEMICALS, AND EVEN COMMON OUTDOOR EXPOSURE WITH ALTERNATELY WET AND DRY CONDITIONS. OF COURSE, THERE ARE MANY MORE POSSIBLE CORROSIVE ENVIRONMENTS NOT MENTIONED HERE.

GALVANIZING THE STEEL, OR COATING IT WITH A SACRIFICIAL LAYER OF ZINC, IS THE MOST WIDELY USED PROTECTIVE SYSTEM IN OUR LUMBER CONNECTOR INDUSTRY. GALVANIZED COATINGS HAVE A PROVEN COMMERCIAL HISTORY UNDER A WIDE RANGE OF ENVIRONMENTAL CONDITIONS.




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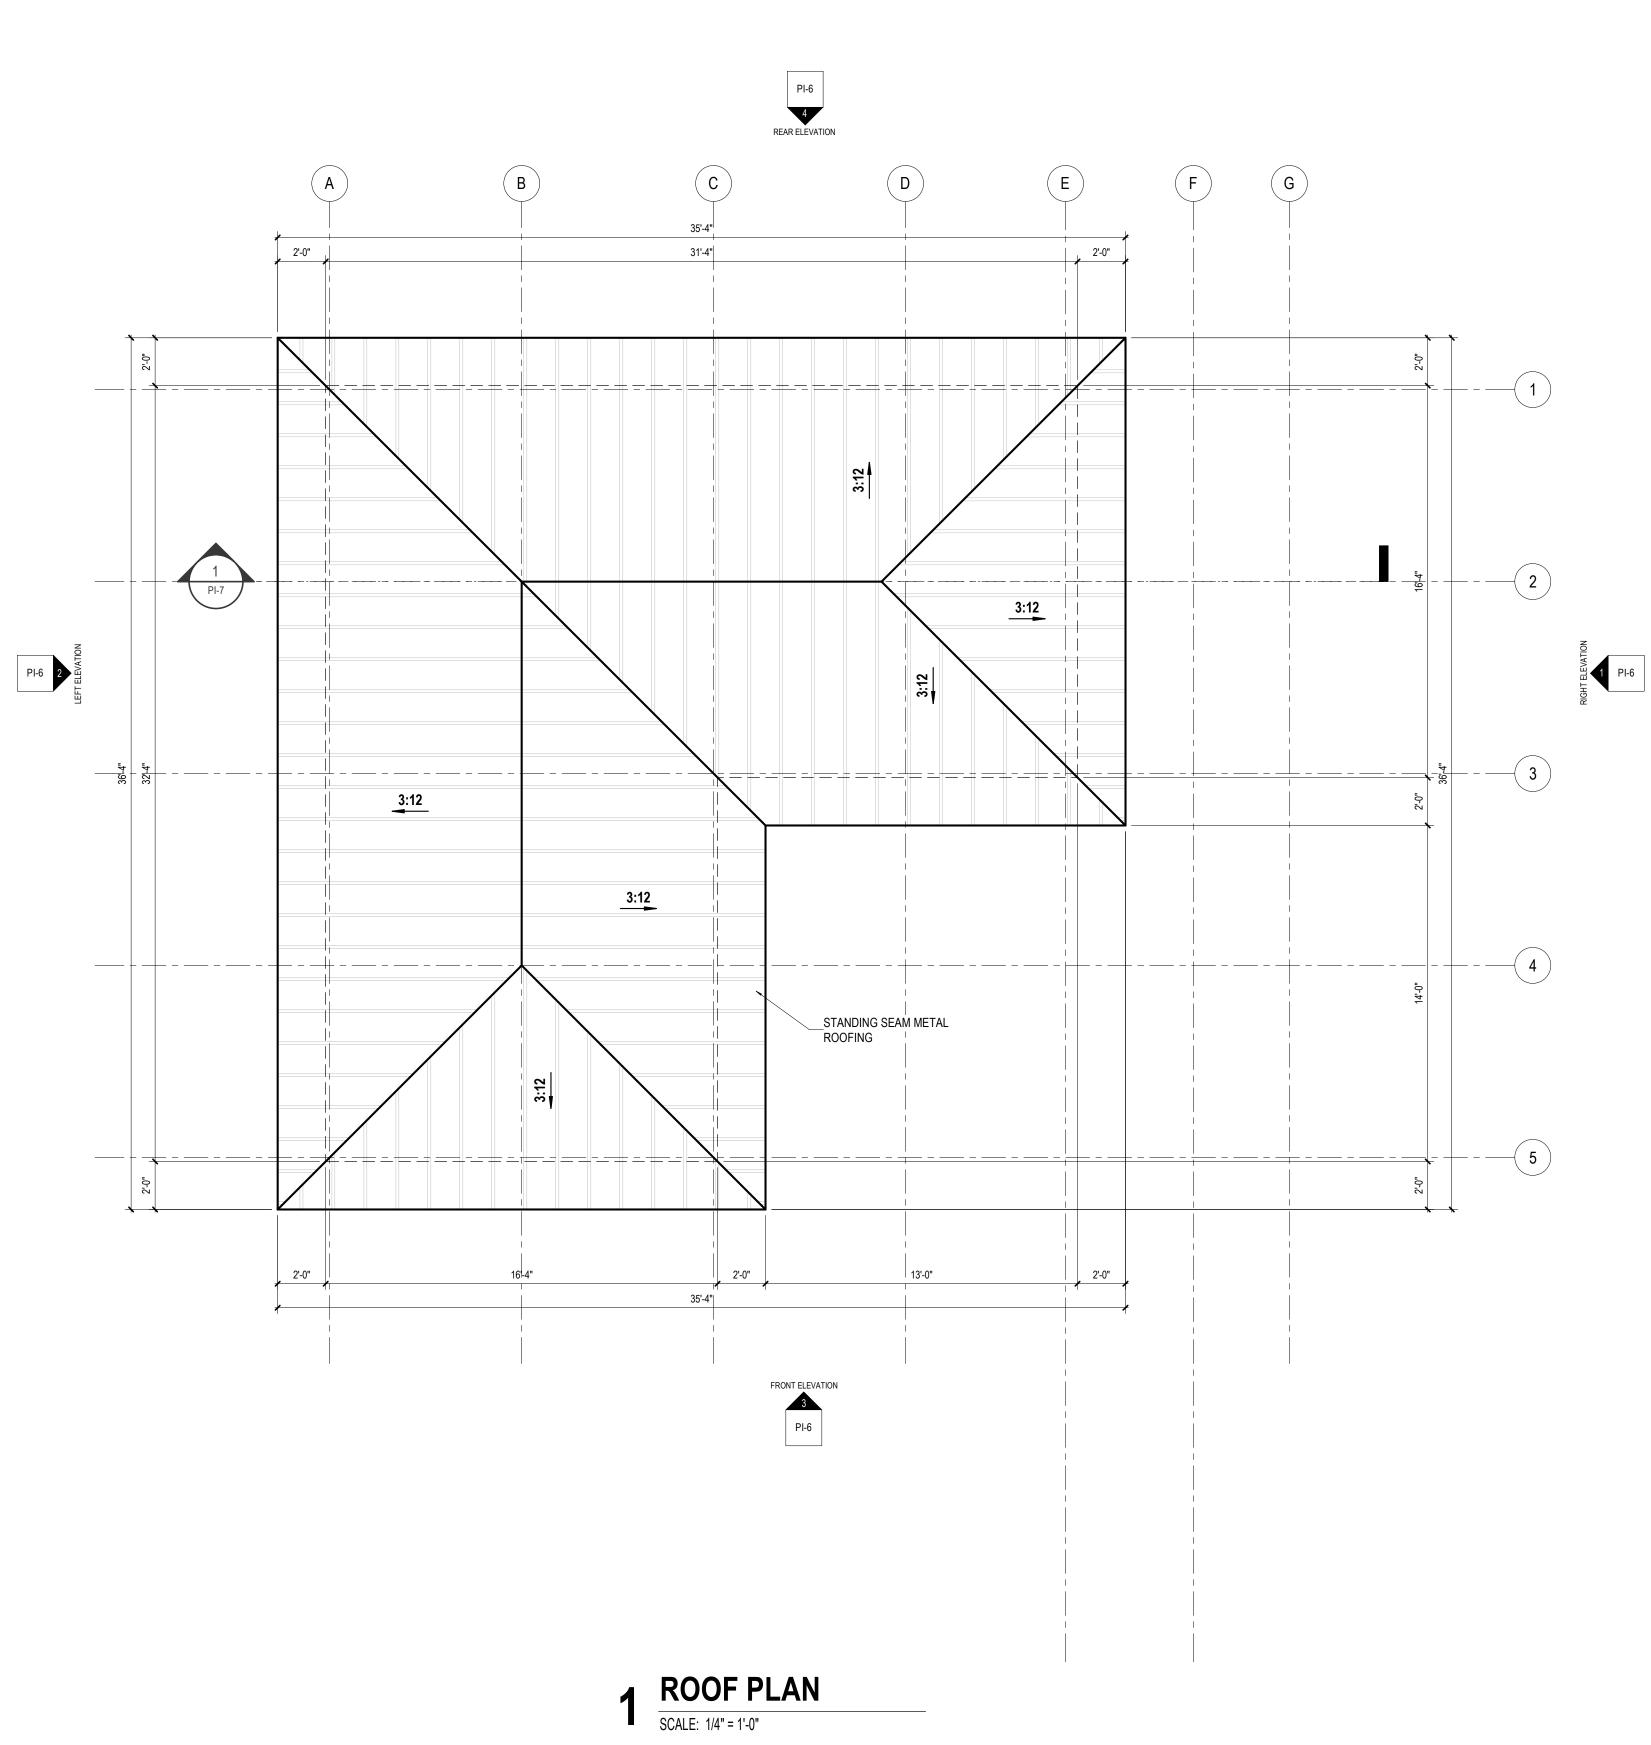







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1 PIER LEVEL ELECTRICAL PLAN SCALE: 1/4" = 1'-0"
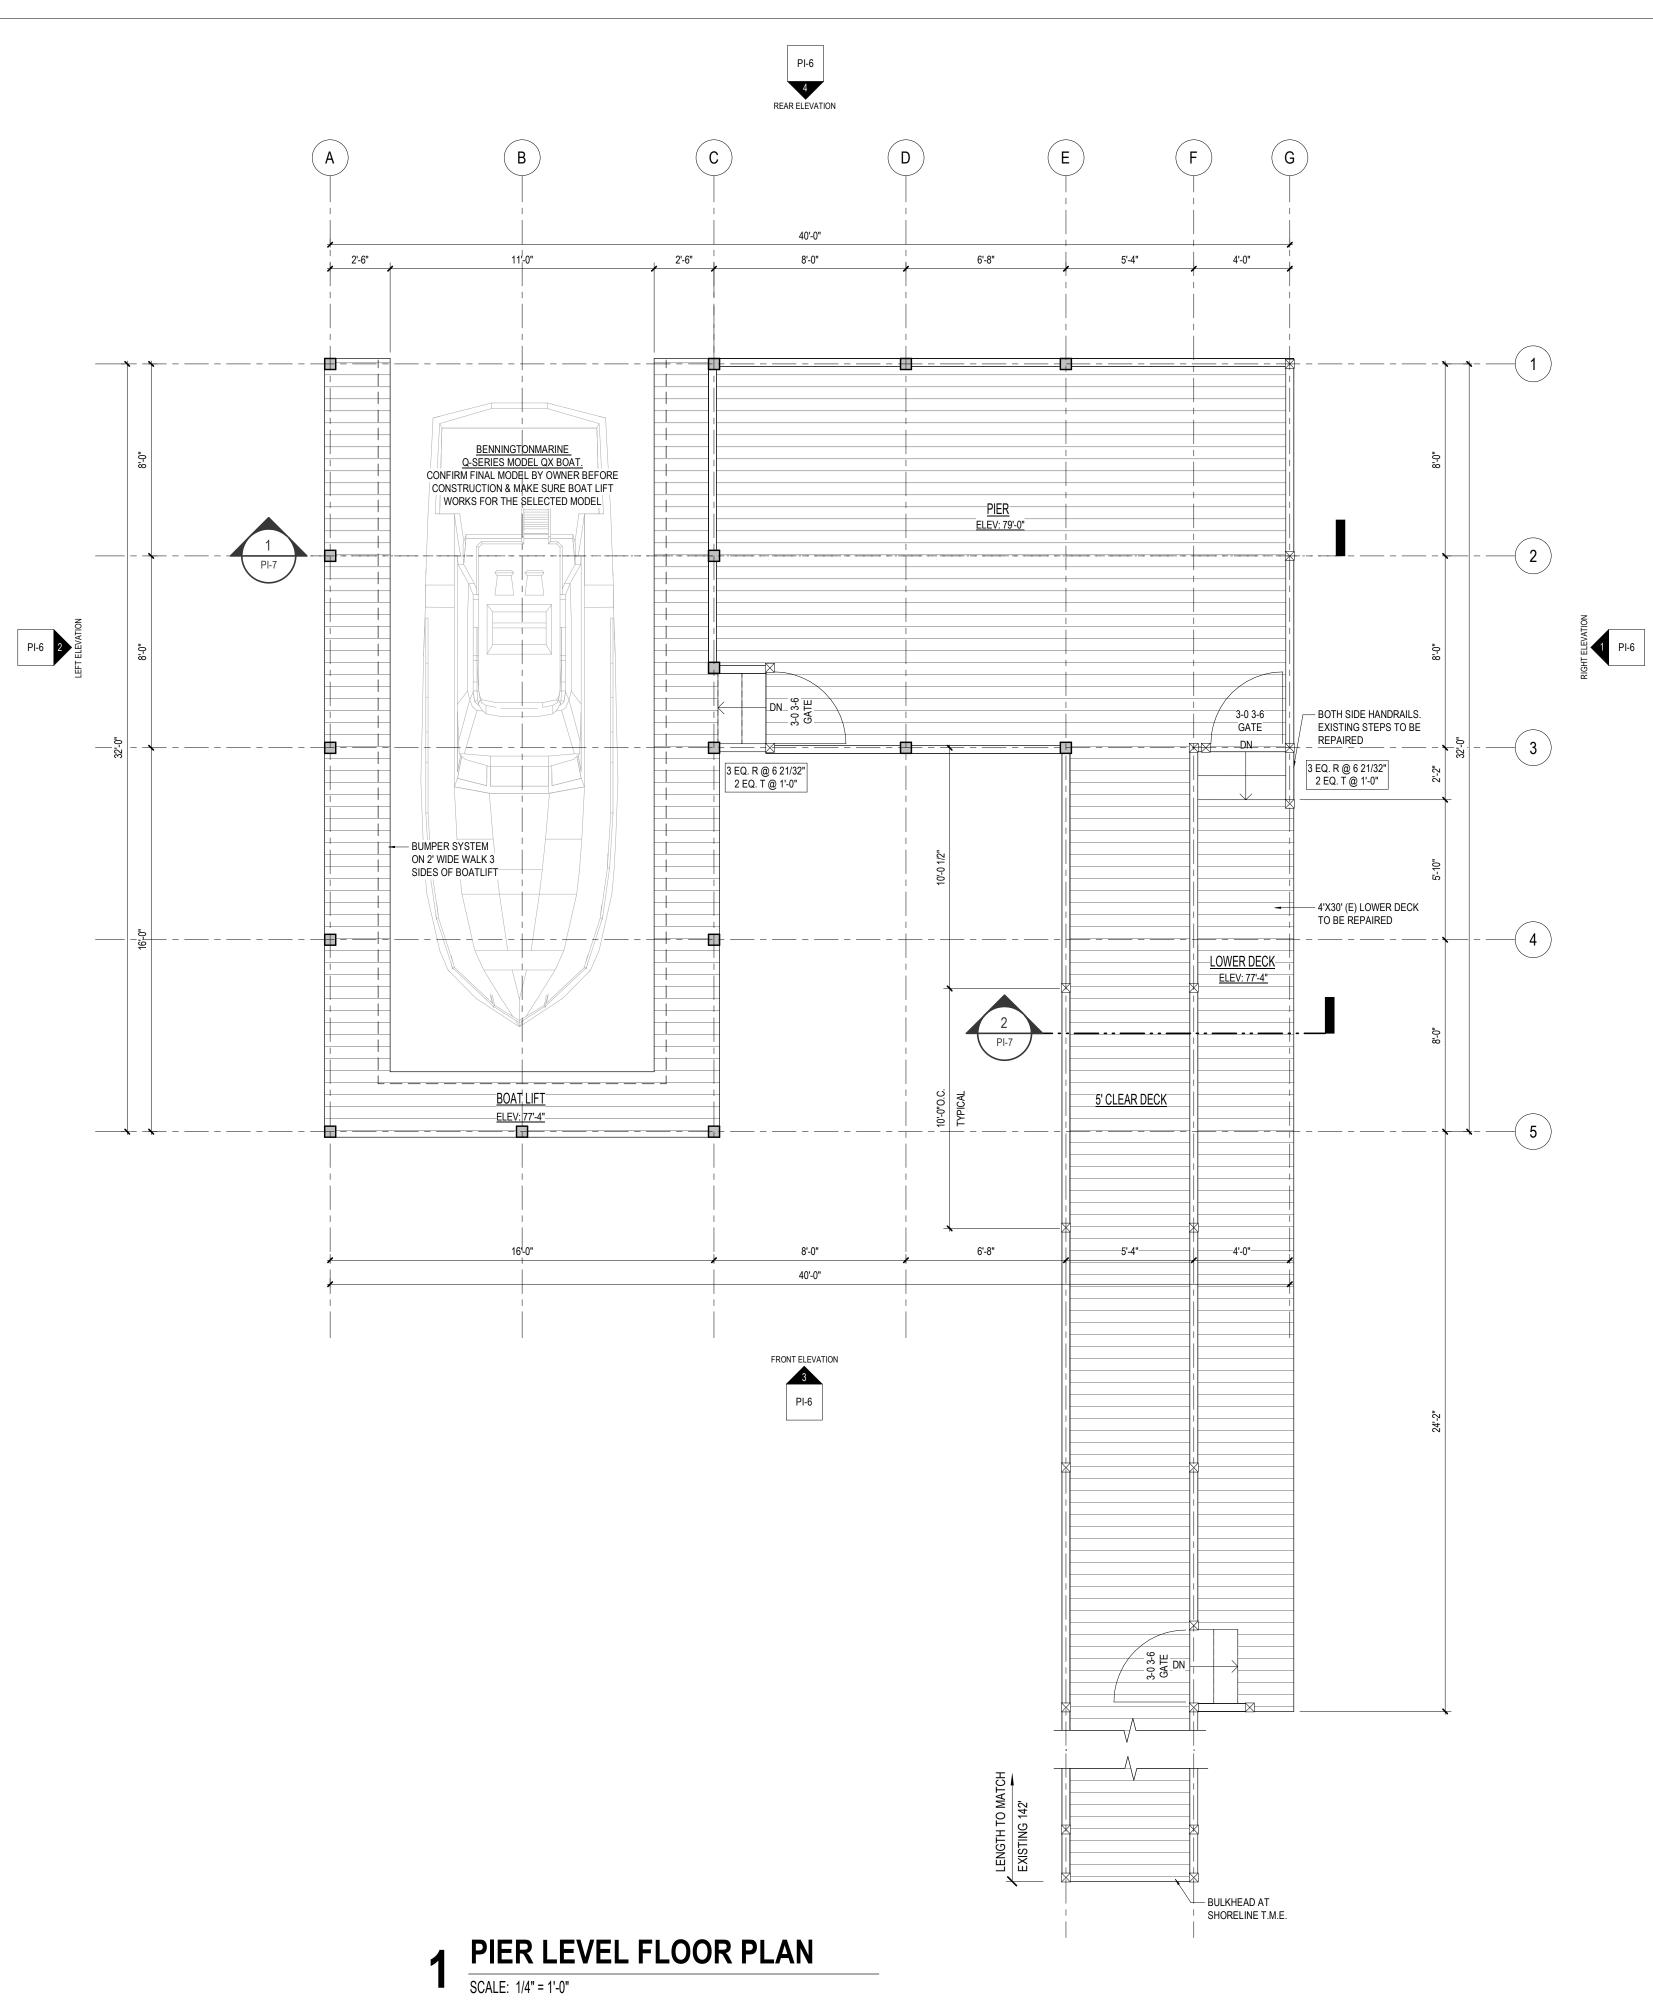
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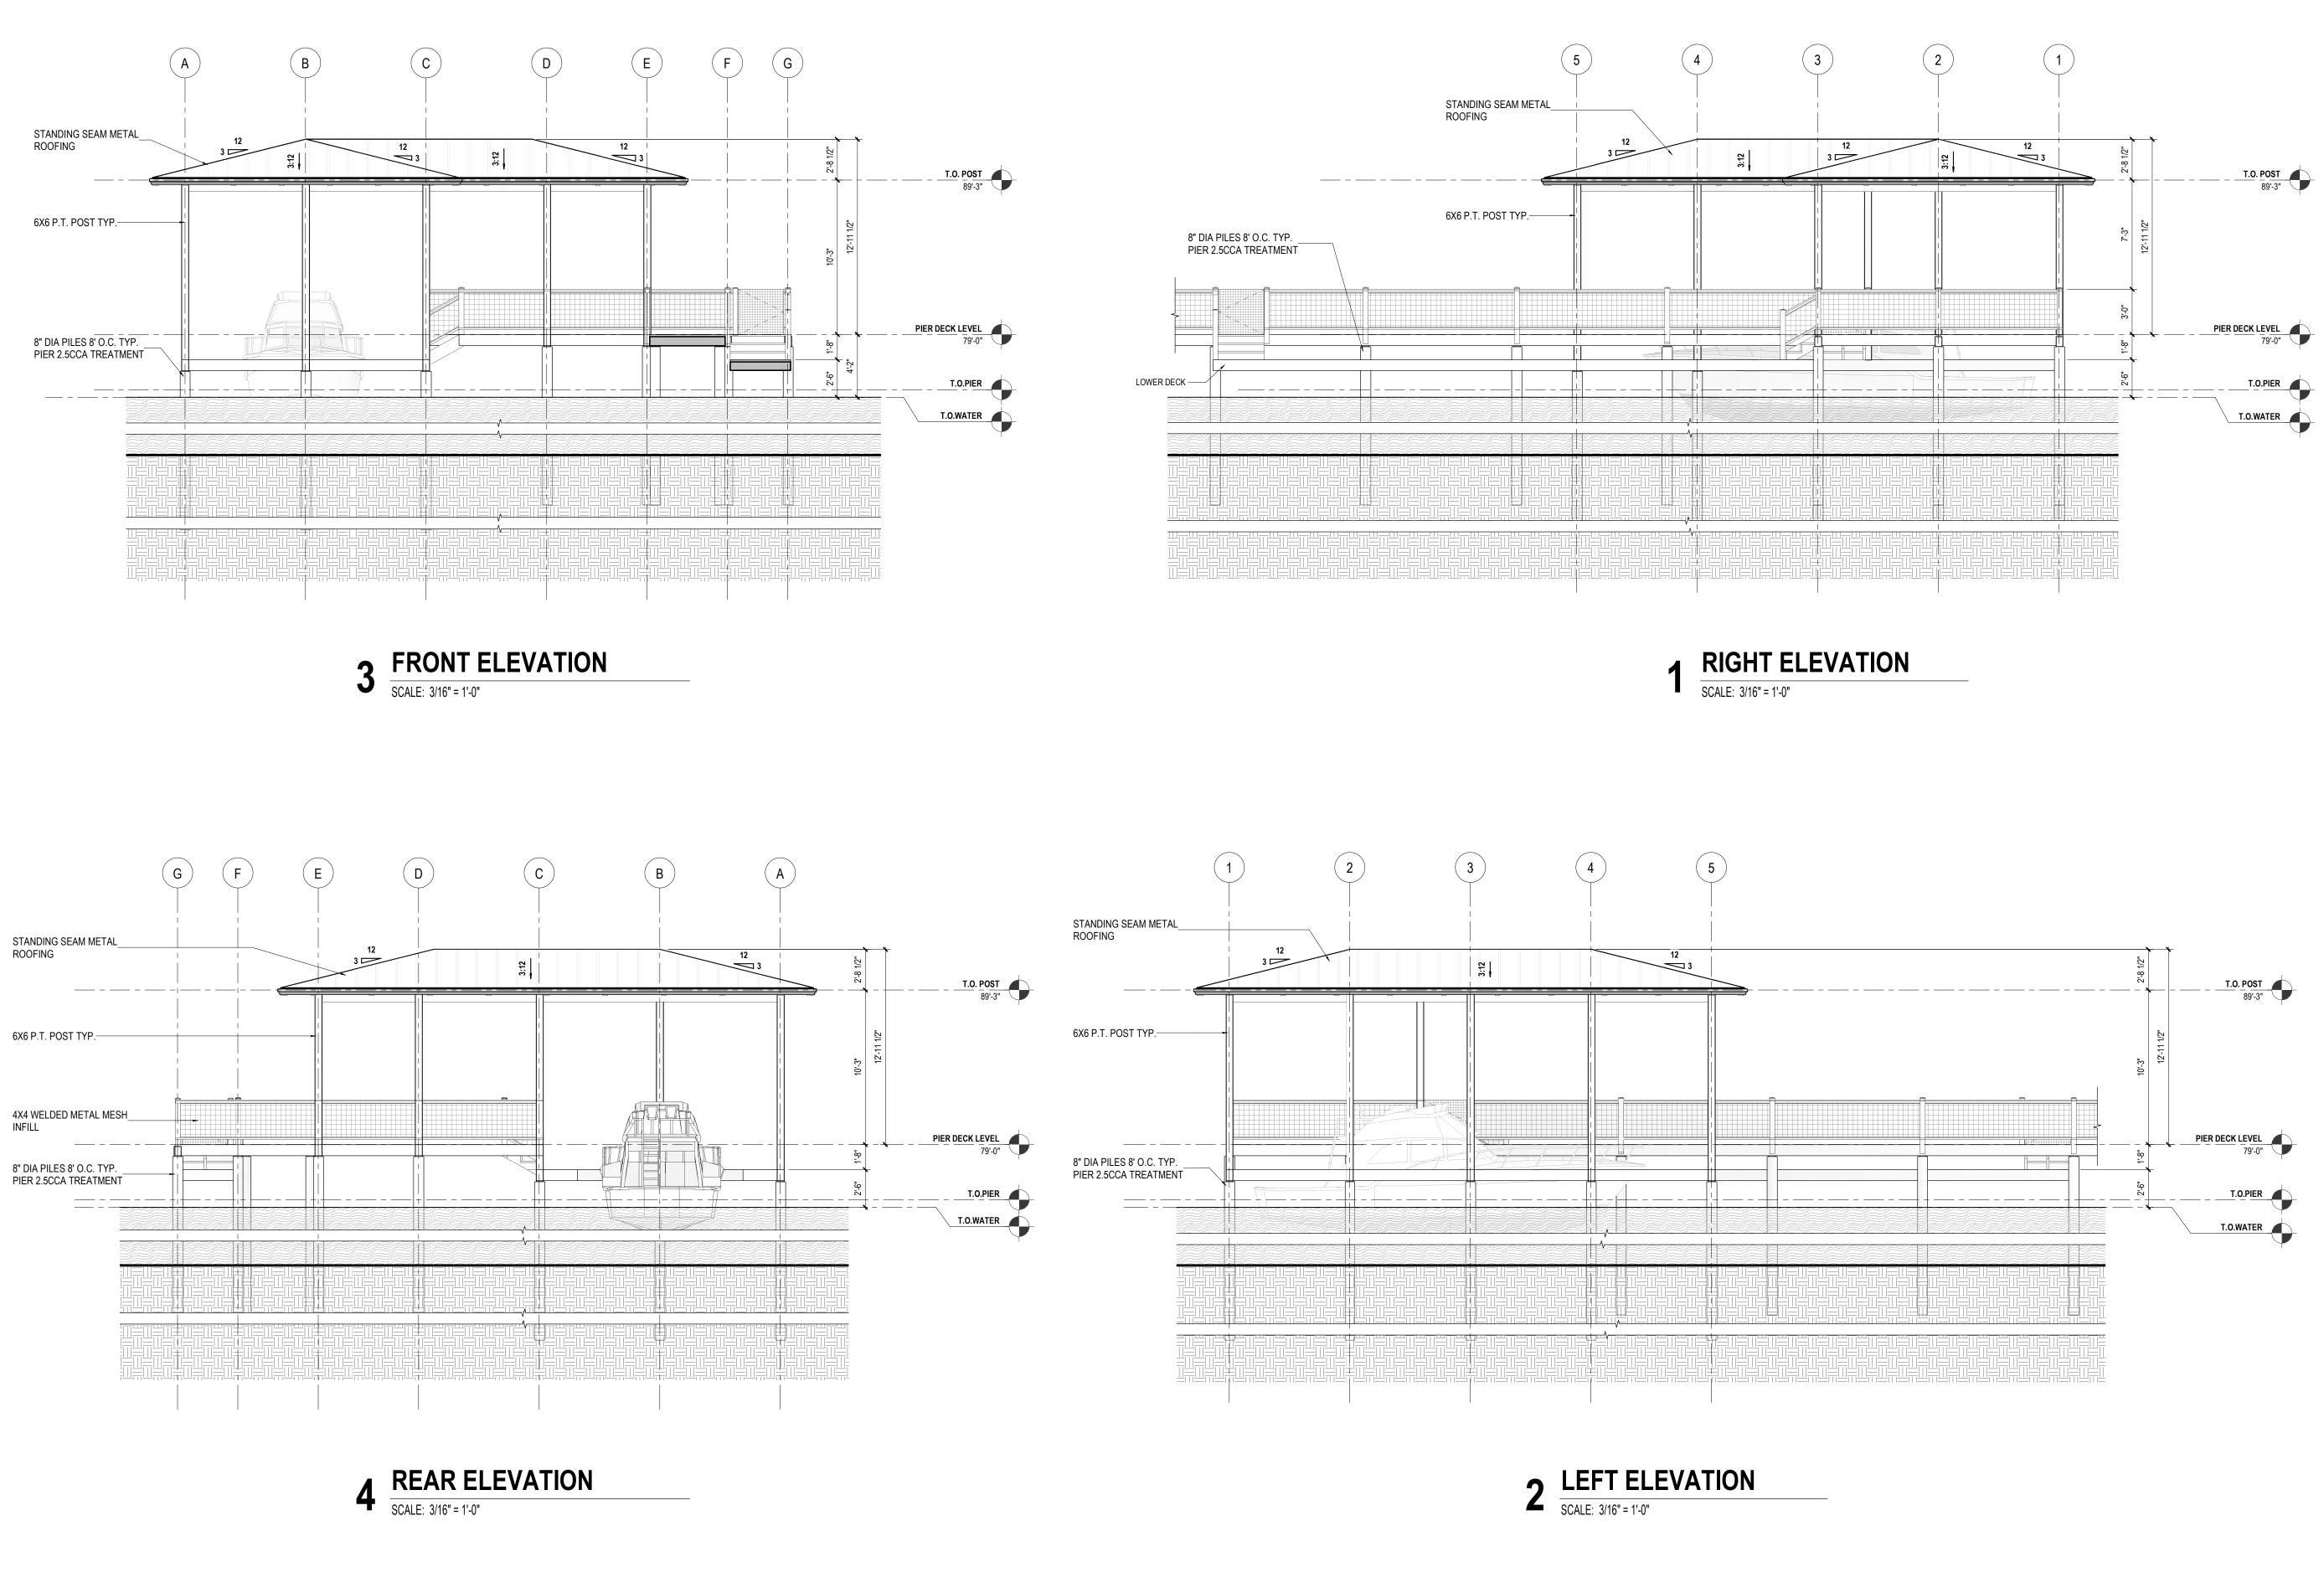
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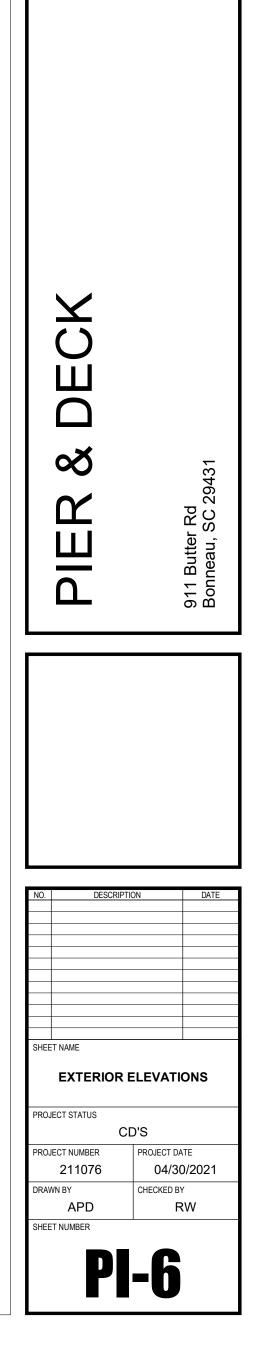
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ELECTRICAL LEGEND

BZ	BUZZER	THERMO	DSTAT
Û	DOOR BELL	⊕ JUNCTIO	DN BOX
\searrow	CEILING MOUNT SECURITY CAMERA		ECTRICAL METER
₹,	WALL MOUNT SECURITY CAMERA	\bigcirc	ECTRICAL PANELBOARD
T	TELEPHONE CABLE		D WATER
$\overline{\mathbb{M}}$	TV CABLE	HB: HOS	SE BIB
Φ	SINGLE OUTLET	∓ HT: HOT उ⊤GAS	WATER
φ	DUPLEX	<u> </u>	
	GFI: WP: WATERPROOF S: SWITCHED		FLUROSCENT LINEAR: SURFACE MOUNT OR UNDER CABINET
Ф	HALF HOT		FLUROSCENT 2X2
Φ	APPLIANCE OUTLET		FLOROSCENT 2X2
₽	QUAD OUTLET		FLUROSCENT 2X4
	FLOOR/CEILING DUPLEX OUTLET OH: OVERHEAD		SURFACE MOUNT LIGHT
⊞	FLOOR/CEILING QUAD OUTLET OH: OVERHEAD	- \ -	PC: PULL CORD LED:
 इ	WALL SWITCHES		WP: WATER PROOF
₽	NUMBER 3: 3-WAY, 4: 4 WAYS, ETC. D: DIMMER	\oplus	SURFACE MOUNT PENDANT LIGHT
9	SMOKE DETECTOR	-¢-	RECESSED LIGHT
Ð	SMOKE & CARBON MONO-OXIDE COMBO DETECTOR	-	RECESSED LIGHT - WALL WASHER
		HD-	WALL MOUNT LIGHT / WALL WASHER
			CEILING FAN
			EXHAUST FAN



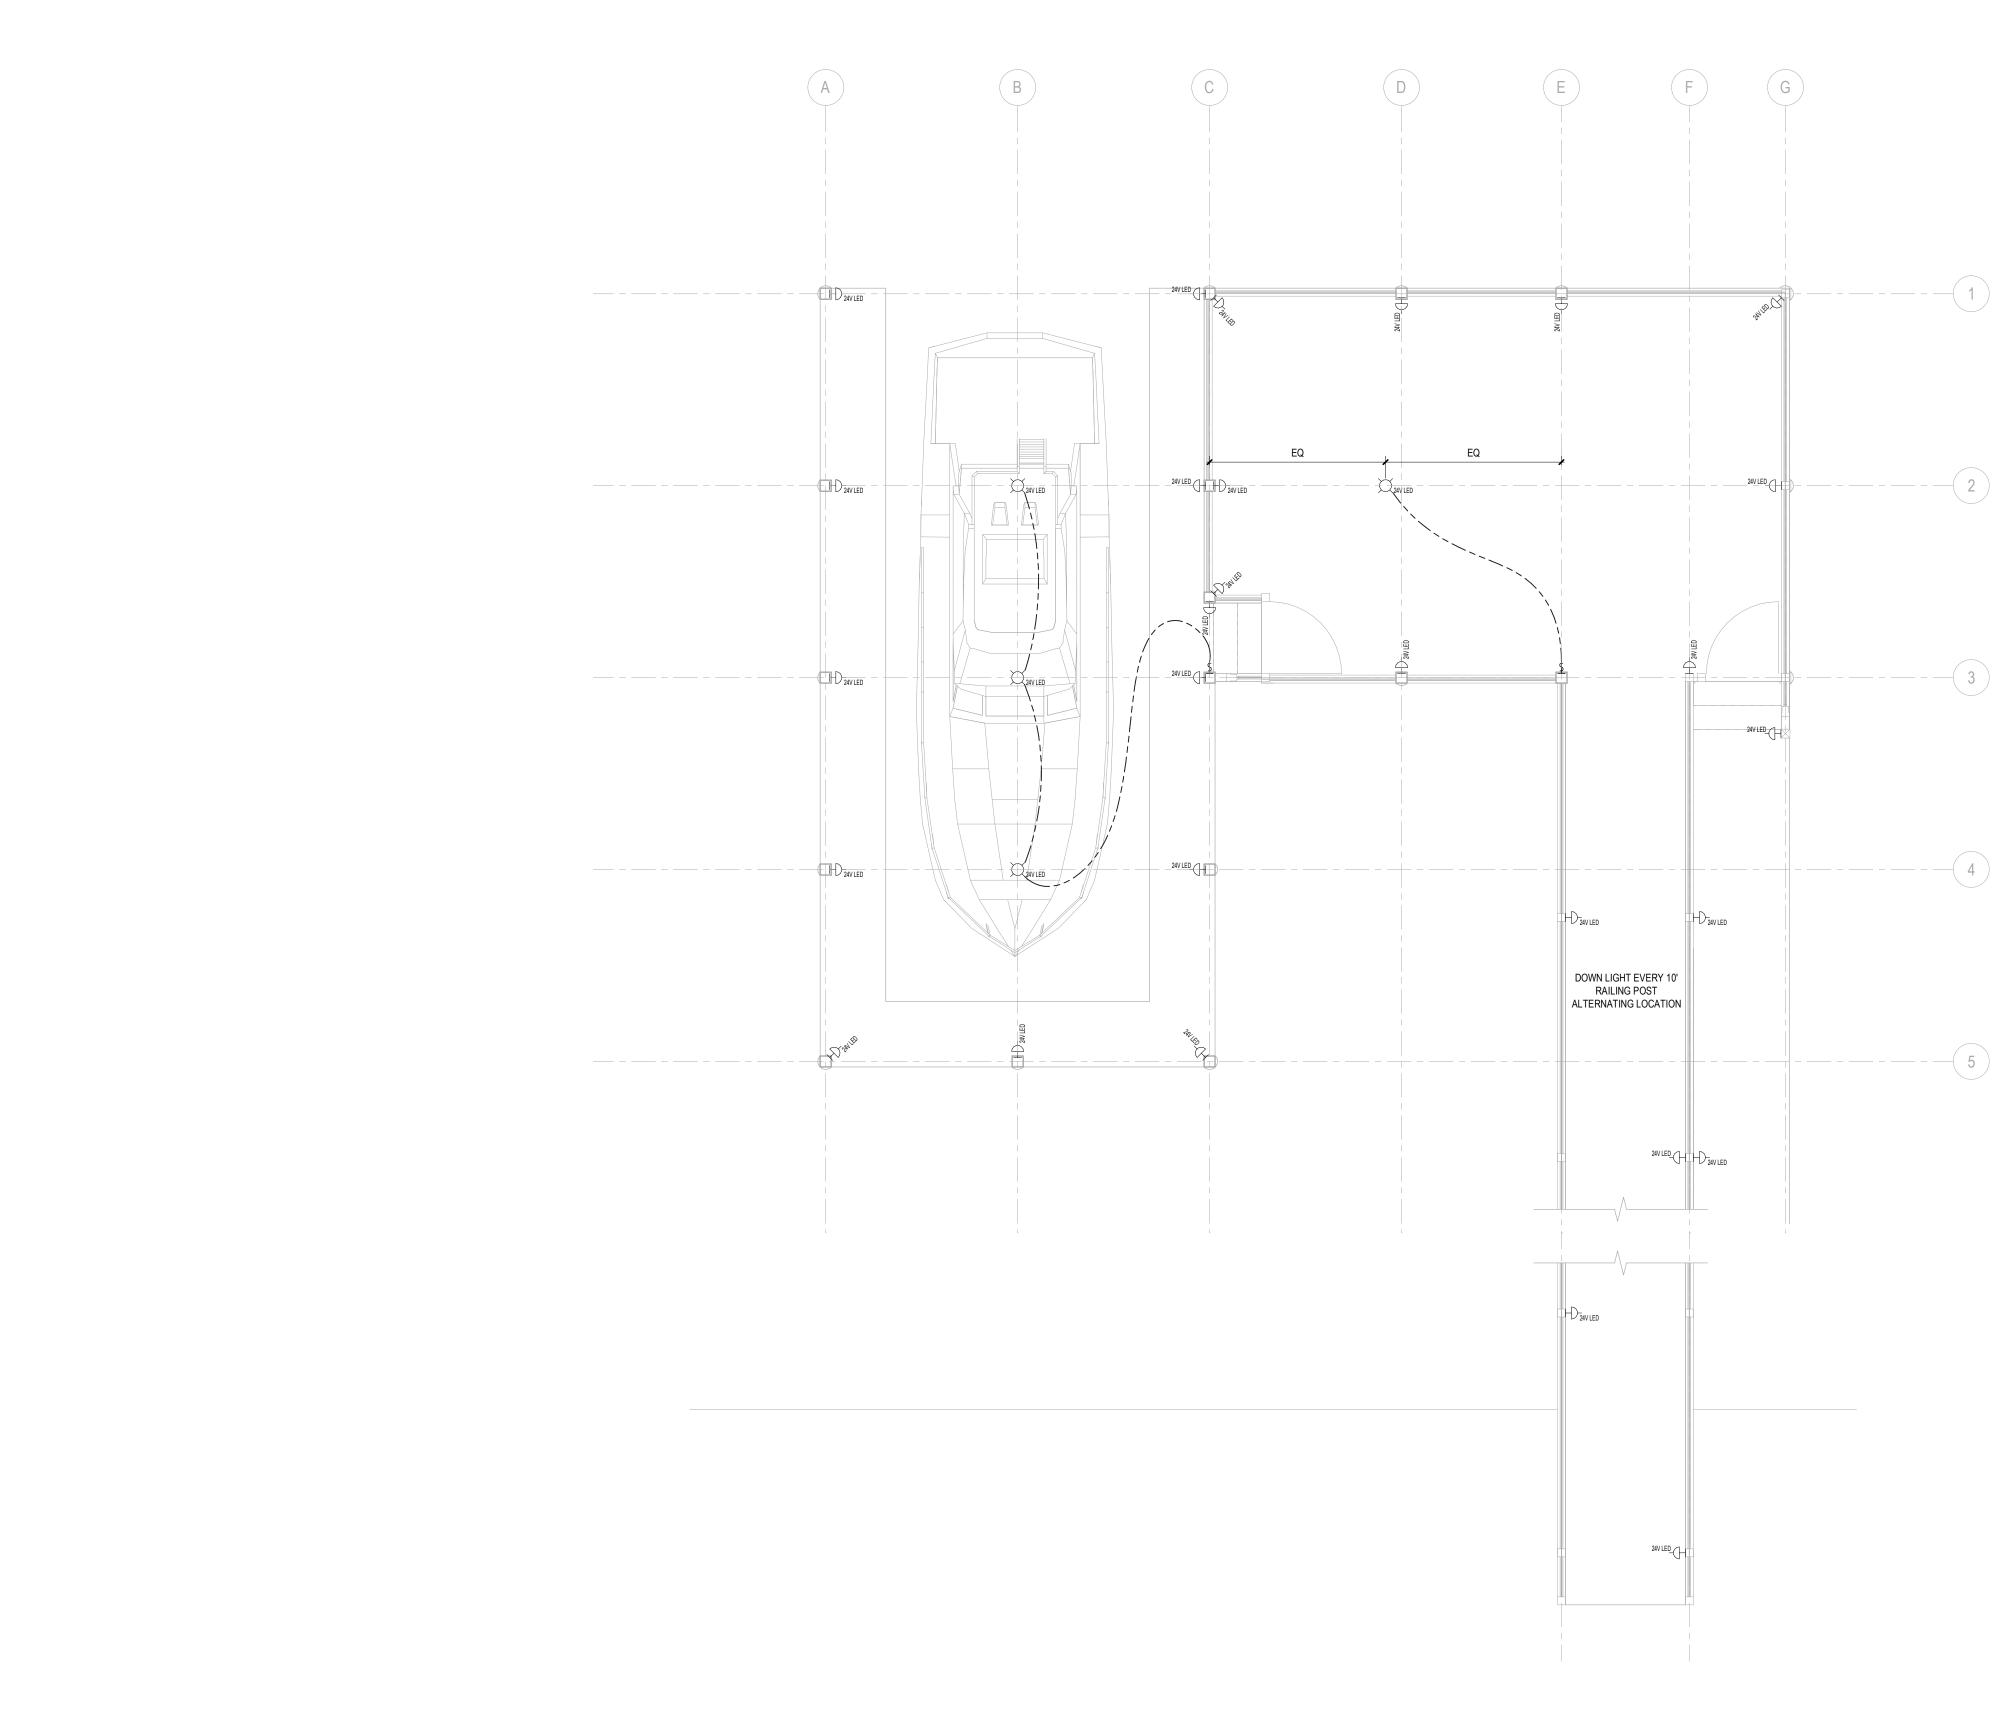

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